



Application Number: LU/12490

Our File Reference Number: Erf 527, Pniel

Your Reference Number: None

Enquiries: Ulrich von Molendorff

Contact No: 021 – 808 8682

Email address: [Ulrich.Vonmolendorff@stellenbosch.gov.za](mailto:Ulrich.Vonmolendorff@stellenbosch.gov.za)

**PER E-MAIL:** [leigh.lackay@absa.africa](mailto:leigh.lackay@absa.africa)

Sir / Madam

**APPLICATION FOR DEPARTURE: ERF 527 PNIEL**

1. The above application refers.
2. The duly authorised decision maker has decided on the above application as follows:

2.1 That the application for a departure in terms of Section 15(2)(b) of the Stellenbosch Municipal Land Use Planning Bylaw 2015 to relax the street building line (middle street ) from **4m to 0m** in order to accommodate the proposed double garage and the common building line(adjacent to Erf 525 & 526) from **2,5m to 0m** in order to accommodate the proposed store on Erf 527, Pniel as indicated on drawing no. 527\_PN drawn by J.F.S Podraft & design, dated November 2020;

**BE APPROVED** in terms of Section 60 of the said Bylaw and subject to the following conditions in terms of Section 66 of said Bylaw:

- a. The approval shall lapse if not acted upon within a period of five years from the date of approval;
- b. The approval shall be taken to cover only the departure applied for and shall not be construed as authority to depart from any other Council requirements or legal provisions;
- c. Building plans must be submitted to this Municipality for approval prior to any building work commencing on site;


**2.1.1 The reasons for the above decision are as follows:**


- a. The proposed double garage is in line with the existing land use of the property;
  - b. The proposal is the logical extension of the existing residential use.
3. You are hereby informed in terms of section 79(2) of the Stellenbosch Municipal Land Use Planning Bylaw, 2015, of your right to appeal the above decision to the Appeal Authority within 21 days from the date of notification of the above decision. Please note that no late appeals or an extension of time for the submission of appeals are permitted in terms of Section 80(1) (a) of the said By-Law.
4. Appeals must be submitted with the prescribed information to satisfy the requirements of Section 80(2) of the said By-law, failing which the appeal will be invalid in terms of Section 81(1) (b) of the said By-Law. The following prescribed information is accordingly required:
- (a) The personal particulars of the Appellant, including:
    - (I) First names and surname;
    - (II) ID number;
    - (III) Company of Legal person's name (if applicable)
    - (IV) Physical Address;
    - (V) Contact details, including a Cell number and E-Mail address;
  - (b) Reference to this correspondence and the relevant property details on which the appeal is submitted.
  - (c) The grounds of the appeal which may include the following grounds:
    - (i) that the administrative action was not procedurally fair as contemplated in the Promotion of Administrative Justice Act, 2000 (Act 3 of 2000);
    - (ii) grounds relating to the merits of the land development or land use application on which the appellant believes the authorised decision maker erred in coming to the conclusion it did.
  - (d) whether the appeal is lodged against the whole decision or a part of the decision;
  - (e) if the appeal is lodged against a part of the decision, a description of the part;
  - (f) if the appeal is lodged against a condition of approval, a description of the condition;

- (g) the factual or legal findings that the appellant relies on;
  - (h) the relief sought by the appellant; and
  - (i) any issue that the appellant wishes the Appeal Authority to consider in making its decision;
  - (j) That the appeal includes the following declaration by the Appellant:
    - (i) The Appellant confirms that the information contained in the subject appeal and accompanied information and documentation is complete and correct
    - (ii) That the Appellant is aware that it is an offence in terms of Section 86(1)(d) of the said By-Law to supply particulars, information or answers in an appeal against a decision on an application, or in any documentation or representation related to an appeal, knowing it to be false, incorrect or misleading or not believing them to be correct.
5. Appeals must be addressed to the Municipal Manager and submitted to his/ her designated official by means of E-mail at the following address: [landuse.appeals@stellenbosch.gov.za](mailto:landuse.appeals@stellenbosch.gov.za)
  6. An applicant who lodges an appeal must pay the applicable appeal fee in terms of the approved municipal tariffs and submit the proof of payment together with the appeal. The LU Reference number on this correspondence, or the applicable Erf/ Farm Number must be used as the reference for the payment of the appeal fee.
  7. The approved tariff structure may be accessed and viewed on the municipal website (<https://www.stellenbosch.gov.za/documents/finance/rates-and-tariffs>) and the banking details for the General Account can also be accessed on the municipal website (<https://www.stellenbosch.gov.za/documents/general/8314-stellenbosch-municipality-banking-details-1/file>).
  8. An applicant who lodge an appeal must also adhere to the following requirements stipulated in terms of section 80(3) to (7) of the said By-law:
    - (a) Simultaneously serve the appeal on any person who commented on the application concerned and any other person as the municipality may determine.
    - (b) The notice by the applicant must invite persons to comment on the appeal within 21 days from date of notification of the appeal.

- (c) The notice must be served in accordance with section 35 of the said legislation and in accordance with the prescripts or such additional requirements as may be determined by the Municipality.
- (d) Proof of serving the notification must be submitted to the Municipality at the above E-mail address within 14 days of serving the notification.
9. Kindly note that no appeal right exists in terms of Section 62 of the Local Government Municipal Systems Act, No 32 of 2000.
10. Kindly note the above decision is suspended, and in the case of any approval, may therefore not be acted on, until such time as the period for lodging appeals has lapsed, any appeal has been finalised and you've been advised accordingly.

Yours faithfully

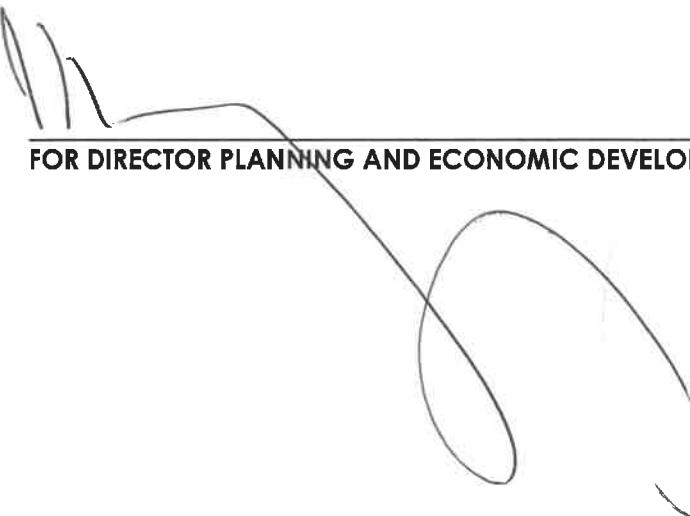  
**FOR DIRECTOR PLANNING AND ECONOMIC DEVELOPMENT**

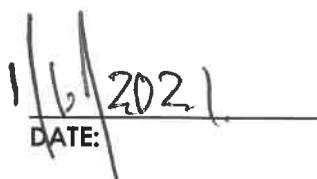  
DATE:



**STELLENBOSCH**

STELLENBOSCH • PNIEL • FRANSCHHOEK

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# ANNEXURE B

(A DEPARTURE TO RELAX THE STREET BUILDING LINE: ERF 527, PNIEL)

SITE & FLOOR PLAN

## NOTES :

## GENERAL :

All measurements must be checked before any building work commence. Preference must be given to dimensions indicated above ensuring from plan. All building work done to be done strictly in accordance with national building regulations & local authorities approved. Any irregularities on plan must be cleared with owner or designer before any work is done.

## Determining shading projections over glazed areas

$$\begin{aligned} P &= \frac{A}{G} + 2000 = 2095 \\ G &= 1355 - 1200 = 155 (\text{ < } 500) \end{aligned}$$

Panel	Glazed area and P/H value	Solar exposure factor	P/H value
1	1200 Window P/H = 2095 / 1200 = 1.75	0.22 for South-eastern facade	1.75

## NATURAL VENTILATION :

$$\begin{aligned} \text{CONSTANTS :} \\ \text{CONDUCTANTS} &= 17 \times 1.4 = 23.8 \\ \text{SHG} &= 17 \times 0.13 = 2.21 \end{aligned}$$

CONDUCTANCE  
Use clear glass in steel frame.  
 $A \times g = 16.4 (\text{ < } 23.8)$

## COVERAGE CALCULATIONS :

$$\begin{aligned} \text{ERF AREA} &= 400 \text{ m}^2 \\ \text{SOUTH-EAST :} \\ &= [1.44 \times 0.37 \times 0.22] \\ &\quad \approx 2 \times (0.24) \\ &= 0.49 \\ \text{TOTAL :} &= 0.49 (\text{ < } 2.1) \end{aligned}$$

## PROPOSED EXTENSION COMPATIBLE WITH ENERGY EFFICIENCY

$$\text{APPROX. ESTIMATED COST} = \text{R} 144 160$$

## SOLAR HEAT GAIN :

$$\begin{aligned} \text{SOUTH-EAST :} \\ &= (A \times S \times E) \\ &= [1.44 \times 0.37 \times 0.22] \\ &\quad \approx 2 \times (0.24) \\ &= 0.49 \end{aligned}$$

## ENERGY CONSUMPTION ALLOWED

$$\begin{aligned} \text{ASSUME LIGHTS ARE ON FROM 17:00 - 22:30 EACH DAY / YEAR THAT IS } 5h / \text{DAY} \\ 52 (\text{ Weeks }) \times 7 (\text{ Days }) \times 5 (\text{ h }) = 1830 \text{ h} \\ \text{THERE ARE :} \\ 2 \times 12W \text{ Lamps} \\ = (2 \times 12W) \\ = 24 \text{ W} \\ = 0.024 \text{ kW} \\ 0.024 \text{ kW} \times 1830 \text{ h} \cdot \text{a} \\ = 43.68 \text{ kWh} \cdot \text{a} (\text{ < } 85 \text{ kWh} \cdot \text{a}) \end{aligned}$$



## GLASS PANELS :

Hazardous untempered clear glass panels and obscured in toilet, min. stem bath. All glass panels have than 50mm from finish floor level to be safety glass and glass panels larger than 0.75m<sup>2</sup> to be safety glass. Doors with glass panels to be safety glass as specified in SABS safety standards SANS 10400 - Part H.

J. F. S. Prodraft & Design  
James Solomon P.S.A.I.  
SACAP. Reg. no. ST1739  
Postbox 426, 21 Stirling street, Piem, 7881  
Ph. : 083 712 6110  
Fax : 086 570 8078

project:  
Proposed alterations to existing dwelling house, double garage, swimming pool, covered stoeps & storage shed.  
owner : Mr. & Mrs S. Davids  
no. 16 Middle street, Piem,  
Erf 527.  
drawing no: 527\_PN

date : November 2020  
scale : 1 : 100  
drawn : J. F. Solomons

## SITE &amp; DRAINAGE LAY-OUT PLAN

SCALE : 1 : 200



**NOTES :****GENERAL :**

All measurements must be checked before any building work commences. Preference must be given to dimensions indicated above outlining from plan. All building work must be done strictly in accordance with relevant building regulation & local authority approval. Any irregularities or plan errors be dealt with engineer or designer before any work is done.

**COMPLIANCE FOR ENERGY EFFICIENCY BUILDINGS :****FLOORS :**

100mm mass concrete floor slab on 250 micron dpm. installed around the vertical edges turned up for the full depth up to 300mm of concrete floor perimeter. Floors shall have an R-value of not less than 1.0

**MASONRY WALLS :**

Cleopatra with plastered both sides internally & externally with no cavity to have min. land R-value of 1.9.

**ROOF ASSEMBLIES :**

Pitched roof : - 100 mm metal roof sheeting, light grey sheets pitched 10 degrees with white board ceiling. 10mm joint reflector seal - door and in-door air film (Soil air) Total R-value = 0.35 + added R-values of reflective insulation, 3 layers of reflective foil insulation. Strength between rafters : 1 layer flexible fibre glass Mattek, R-value = 1.4. Total R-value = 3.15, direction of heat flow is upwards.

J. F. S. Prodraft & Design  
James Solomonson (P.S.A.T.)  
SACAP. Reg. No. ST1729

Postbox 1024, 21 Starling street, Priesl, 7881  
Ph.: 083 712 6110  
Fax: 086 570 6078

**project:**

Proposed alterations to exist. dwelling house , double garage , swimming-pool , covered stoeps & storage shed.

owner : Mr. & Mrs. S. Davids  
no. 16 Middle street , Priesl,  
Erf 527.

drawing no : 527 - A

date : November 2020

scale : 1 : 100  
drawn : J.F. Solomons

100 mm metal roof sheeting to match existing with corresponding slopes of 18 degrees as indicated.

Fibre cement fascias 225 x 12.5mm as available from suppliers.

Automated alum. garage roller door to manufacturer's detail.

Columns and low wall plastered and painted to match existing.

250 x 70mm Conc. Strip Fdn.

**SECTION A.A.**

SCALE : 1 : 100

Proposed extension of existing roofing sheets with similar pitch over sleep area.

Galv. steel railing on low wall fixed between columns by specialists.



No openings in railing wider than 90mm as indicated.

**SECTION F.F.**

SCALE : 1 : 100

Block up existing opening and restore facade to match existing.

Install new chimney to built-in braai and render watertight.


Proposed flat roof over prop. step pitched at 3 degrees

Fibre cement fascia as 225 x 12.5mm painted.

Galv. steel railing 100mm high.

**NORTH WEST ELEVATION**

SCALE : 1 : 100

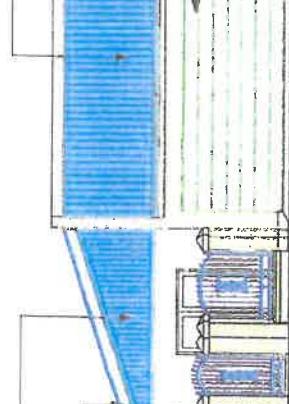

Prepainted 100 mm metal sheet cladding fixed to SA. pine frames.


225 x 12.5mm fibre cement fascias painted to match existing.

Galv. steel railing on low wall fixed between columns.

**NORTH EAST ELEVATION**


SCALE : 1 : 100

Existing dwelling in relation to proposed alterations & extension

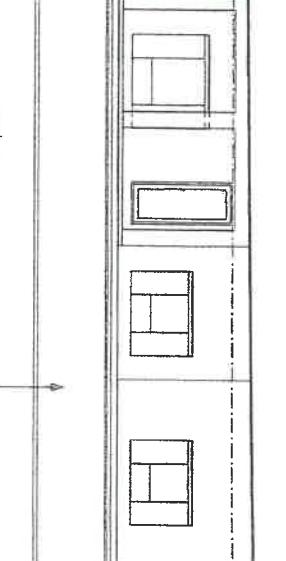

Existing dwelling in relation to proposed alterations & extension

SCALE : 1 : 100

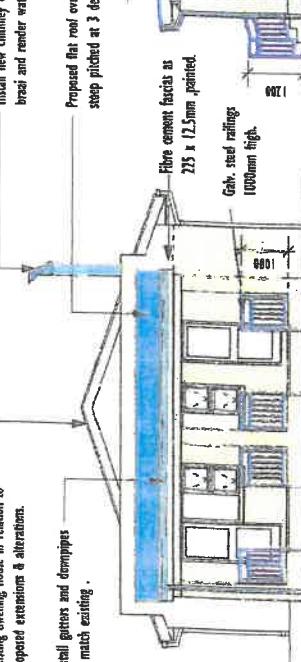**SOUTH EAST ELEVATION**

SCALE : 1 : 100


## NOTES :

## GENERAL :

All measurements must be checked before any building work commences. Permissions must be given to dimensions indicated above measuring from FFL. All building work must be done strictly in accordance with National Building Regulation & local authorities agreed. Any irregularities or plan errors must be cleared with owner or designer before any work is done.

**WOODEN DRYWALL PANEL CONSTRUCTION :**

Fibre cement cladding 225 x 12mm fixed with under-lay layer to 114 x 12mm vertical studs at 600mm c/c tied together at top & bottom angles, at top & bottom with top & bottom plates 114 x 30mm with horizontal stiffeners at 600 to 900mm c/c. Window and door openings to be rendered watertight onto by specialists.

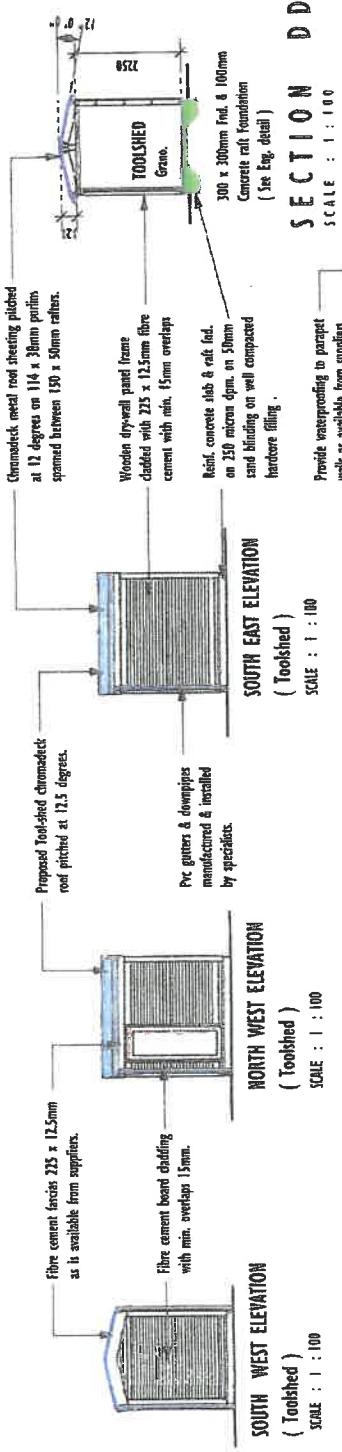

**FLAT ROOF CONSTRUCTION : ( Lean-to-roof )**

IBR metal roofing sheet pitched at 3 degrees slope on 15 x 50mm purlins at 180mm c/c on 114 x 50mm rafters at +/- 750mm c/c to eaves. Wall lining, galv. steel brackets as is available from suppliers & on 50 x 220mm bearer beam fixed to columns, beams, hoop iron straps built-in for min. 4 brick courses deep.

**ROOF CONSTRUCTION :**

IBR metal roof sheeting pitched at 18 degrees to match existing on 410 on 76 x 50mm purlins at +/- 800mm c/c on galvanised galvanized roof trusses at +/- 800mm c/c by precast design on 114 x 50mm webplate fixed to wall beams. Hoop iron straps built-in for min. 4 brick courses deep. Rafter ends to be rendered of with 225 x 12.5mm fibre cement plaster. Flashing gutters and downpipes to match existing.

**CEILING CONSTRUCTION :**

Rhino board ceiling plastered smooth with crestings ( steps with noty plst ) and painted with joints covered with mesh cloth as per supplier's specifications. Rhino board ceiling noted against 30 x 30mm battens at 450mm centres with members across to form squares. Jiffy gypsum plaster board corner ( step noty pine ) or similar in corners against walls. Overhangs to be boxed and boxed off with noty boards around half round mitres over joints quadrants in corners.

**MASONRY CONSTRUCTION :**

Wall plastered and painted to owner's preference. Masonry openings in each room. Min. 4 layers brickwork above all openings, supported by precast reinforced concrete blocks with min. bearing earth side of 220mm. Install 375 micron cpe on walls min. 220mm above ground level. Install brickwork every 4th brick course vertically. Class 11 mortar mix between brickwork. Window sills to match rendering. Threshold not more than 30mm high.


**FLOOR CONSTRUCTION :**

Floor covering on 25mm sand and cement floor screed on 100mm mesh reinforced concrete base slab on damp proof membrane polythene .250 micron on 50mm sand bedding on wall compacted hardcore filling in layers of max. 150mm to 175mm. Aspho. Damp proofing to be turned up around parameters of concrete floor to full vertical height or higher than their internal masonry striking in corners against walls.

**GROUNDS - FLOOR PLAN ( Tool Shed )**  
SCALE : 1 : 100

**SECTION D.D.**

SCALE : 1 : 100

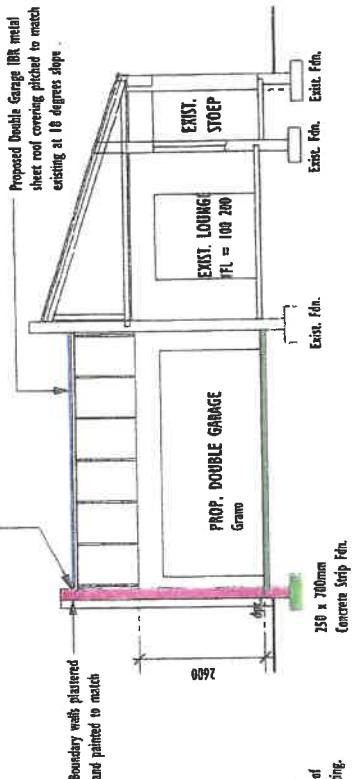**SECTION A.A.**

SCALE : 1 : 100

**J. F. S. Prodraft & Design**

J. James Solomon ( P.S.A.T. )  
S.A.C.A.P. Reg. no. ST11729  
Postbox 424, 21 Starkie street, Pretoria, 17681

Ph. : 083 712 6110  
Fax : 086 570 6078

owner :

Mr. & Mrs. S. Davids  
no. 16 Middle street , Pretoria,  
Erf 527.

drawing no : 527 - P2



date : November 2020

scale : 1 : 100

drawn : J. F. Solomon

**SECTION B.B.**

SCALE : 1 : 100

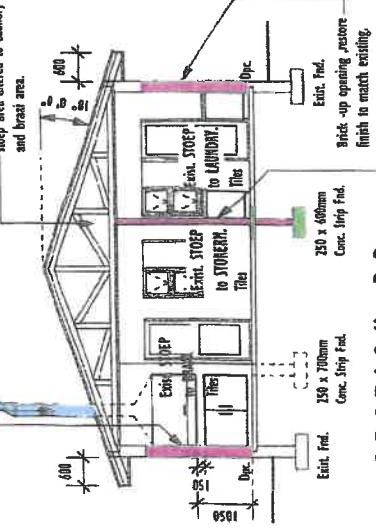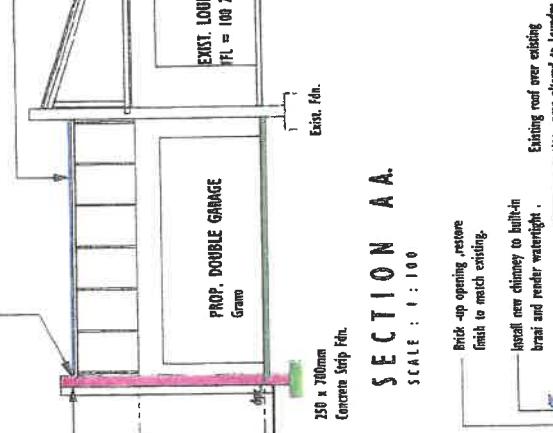


## NOTES :

## GENERAL :

All measurements must be checked before any building work commence. Preference must be given to dimensions indicated above measuring from plan. All building work must be done strictly in accordance with national building regulation & local authority approved by immigrations or plan must be checked with owner or designer before any work is done.

## SWIMMING POOL :

1. Site which contains a swimming pool is to have a wall or fence of 1200mm high, with controlled self-closing & self locking gates in such fence or wall as to restrict access from public areas.
2. Constructional requirements of steel fences or gates is to comply with SANS 1390, SANS 10134.
3. Openings in steel fences not more than 800mm wide.
4. The owner of any site which contains a swimming pool shall ensure that access to the swimming pool is controlled.
5. Any owner who fails to comply with the requirements of subregulation (1) shall be guilty of an offence.

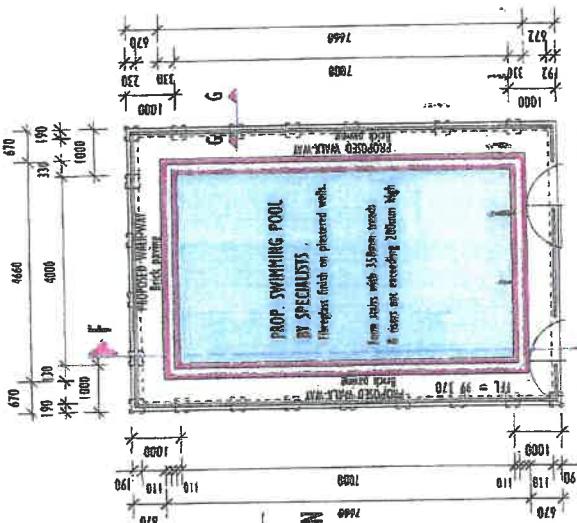

## FLAT ROOF CONSTRUCTION :

18mm metal roofing pitched at 3 degrees slope or 16 x 50mm purfins at +/- 800mm c/c on fascia 410 x 228 x 30mm rafters at +/- 800mm on 114 x 38mm valplaste, fixed with hoop iron straps - built-in for min. 1 brick course deep. Other ends wrapped in damp - built-in & tied down with hoop iron strap - built-in - Rafter ends bounded off with 225 x 12.5mm fibre cement fascias, with gutters and downpipes to match existing. Beam filling to be done where so required. Sealant & similar waterproofing against parapet walls.

## MASONRY CONSTRUCTION :

Walls rendered and painted to owner's preference. Bricks openings 2 high, 2 lower. Min. 4 layers brickwork above all openings, supported by precast rein. concrete blocks with min. bearing each side of 220mm. Install 375 micron dc on walls min. 210mm above ground level. Install brickcourse every 4th brick - dense vertically. Class 11 mortar mix between brickwork. Windowsills to match existing.

## FLOOR CONSTRUCTION :

25mm sand cement floor screed on 100mm mesh reinforced concrete floor slab on damp proof membrane polypropylene 250 micron on 50mm sand bedding on well compacted hardcore filling in layers of max. 150mm to 10% incl. astico. Ramp profiling to be turned up around parameters of concrete floor to full vertical height or higher than floor.

No opening to be wider than 90mm

Custom made galv. steel garage roller door by specialist.

Install galv. steel railings min. 700mm high, by specialist, with no opening wider than 90mm.

Gutters and downspout 100mm downpipe prc. as is available from supplier.

External wall plastered and painted to match existing building finishes.

## NORTH WEST ELEVATION

SCALE : 1 : 100

## EFF BOUNDARY :

Parapet walls to be rendered  
watertight with approved products.

## PROPOSED STORE ROOM

Gated

No ceiling required with  
ceilings left exposed.

## EFF BOUNDARY :

Parapet walls to be rendered  
watertight with approved products.

## PROPOSED SWIMMING POOL

Fibreglass finish by specialist.

## SECTION E.E.

SCALE : 1 : 100

## PROPOSED STORE ROOM

Gated

2.2m x 4.8m wide

Aluminium windows as per  
wipers catalogue specification.

Gutters and downspout 100mm downpipe prc. as is available from supplier.

External wall plastered and painted to match existing building finishes.

## SECTION F.F.

SCALE : 1 : 100

## PROPOSED SWIMMING POOL

Fibreglass finish by specialist.

Reinf. concrete layer mixed with an impervious bonding agent, to prevent infiltration of ground water thru walls with no opening wider than 90mm.

Gutters and downspout 100mm downpipe prc. as is available from supplier.

External wall plastered and painted to match existing building finishes.

## SECTION G.G.

SCALE : 1 : 100

## PROPOSED SWIMMING POOL

Fibreglass finish by specialist.

## GROUND FLOOR PLAN ( Store room )

SCALE : 1 : 100

## GENERAL :

All measurements must be checked before any building work commence. Preference must be given to dimensions indicated above measuring from plan. All building work must be done strictly in accordance with national building regulation & local authority approved by immigrations or plan must be checked with owner or designer before any work is done.

Site which contains a swimming pool is to have a wall or fence of 1200mm high, with controlled self-closing & self locking gates in such fence or wall as to restrict access from public areas.

Constructional requirements of steel fences or gates is to comply with SANS 1390, SANS 10134.

Openings in steel fences not more than 800mm wide.

The owner of any site which contains a swimming pool shall ensure that access to the swimming pool is controlled.

Any owner who fails to comply with the requirements of subregulation (1) shall be guilty of an offence.

J. F. S. Prodraft & Design  
J. M. S. Solomons ( P.S.A.T. )  
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Postbox 424, 21 Starkling street, Phel, 7681  
Ph. : 083 712 6110  
Fax: 088 607 6078

Proposed alterations to existing dwelling  
house, double garage, swimming-  
pool, covered stoeps & storage shed.  
owner : Mr. & Mrs. S. David  
no. 16 Middle street , Phel,  
Ef 527.  
drawing no. 527 - Pn  
date : November 2020  
scale : 1 : 100, 1:200  
drawn : J. F. Solomons